

1. LAND IS SUBJECT TO RESERVATIONS AND CONDITIONS 2. LAND EXCLUDES MINERALS AUTO CONSOL 868-80 (LOTS 5-10 SEC 45 DP 802) 1. LAND IS SUBJECT TO RESERVATIONS AND CONDITIONS CT's 5/6600, 6/6600, 7/6600, 8/6600, 9/6600, 10/6600 1. LAND IS SUBJECT TO RESERVATIONS AND CONDITIONS 2. LAND EXCLUDES MINERALS CT's 1/376201, 2/376201, 3/376201, 4/376201 1. LAND IS SUBJECT TO RESERVATIONS AND CONDITIONS

AUTO CONSOL 2686-159 (LOTS 1 AND 2 IN DP 6600) 1. LAND IS SUBJECT TO RESERVATIONS AND CONDITIONS

AUTO CONSOL 2284-67 (LOTS 3 AND 4 IN DP 6600)

MGA

2. LAND EXCLUDES MINERALS CT 3/104516 1. LAND IS SUBJECT TO RESERVATIONS AND CONDITIONS 2. LAND EXCLUDES MINERALS

CT 1/433017

SUBJECT TITLE NOTATIONS :-

2. LAND EXCLUDES MINERALS

1. LAND EXCLUDES MINERALS

JOB REFERENCE : A4050

DWG No. A4050-TOPO&UTIL-REV-E DATE OF SURVEY: OCT 2023 REGISTERED LAND SURVEYOR UNDER THE SURVEYING AND UTILITY LOCATOR: LB SPATIAL INFORMATION ACT, 2003

© ASTREA 2023 - UNAUTHORISED USE IS PROHIBITED PIT ANNOTAION ADDED 08.10.2024 ADDITIONAL SURVEY DATA 30.09.2024 AMENDMENTS 26.08.2024 16.11.2023 PLAN SHEETING REV

AMENDMENTS

DATE

UTILITY ASSETS LEGEND

COMMS TELEPHONE LINE

ELECTRICITY

Subsurface utility investigation was undertaken by Atrea Pty Ltd, the plan is to be read inconjuction with the subsurface utility investigation report. Positions are based on Astrea Class A & B point surface indicator(s) located during field survey. Confirmation of the exact position should be made to the relevant authorities prior to any excavation work. Other services may still exist.

This plan shows a representation of the dwg model. this model should be viewed in a cadd environment to interpret this information. This utility plan is valid for 28 days starting from the date of the issue, as underground utility works are often updated. Electricity cables are not necessarily enclosed in conduits and are not necessarily covered with markers, tape or other indicators of their presence.

6. All services have been electronically traced in the field and are shown here for diagrammatic purposes only. Depths shown are approximate only and should be verified prior to works. This plan includes information describing the location of subterranean features, which were purported to exist at the time of the survey. This information was

compiled from a combination of field techniques and available data from cooperating utility authorities. Whilst all care has been taken in the preparation of this plan of survey, we cannot guarantee that the plan is without flaw of any kind. SUBSURFACE UTILITY INFORMATION (SUI) AS5488 LOCATION CLASS


Labelling utility information by a classification code allows the user of this information to

understand clearly how the information was collected and then place an appropriate

CLASS B: Information is collected by designating the horizontal and vertical location of underground utilities by using electromagnetic pipe and cable locators, sondes or flexi-trace, ground penetrating radar and acoustic pulse equipment. This is the most common form of utility locating and although an X, Y and Z axis can be established it is not always entirely accurate due to differing electromagnetic fields, soil conditions and multiple banks of cables affecting the locating signal.

CLASS C: Information is collected by correlating the survey of visible utility surface features such as marker plates or water hydrants and acquired Dial-Before-You-Dig plans to "draw" a string which shows the approximate position of services. This method does not usually show multiple banks of cables and does not always show three dimensional information. Electronically traced locate marks with poor scratchy signals are represented

CLASS D: Information is the most basic level of utility locations using only information based on existing Dial-Before-You-Dig plans and by measuring boundary offsets etc. This method of utility locations should always be treated as an indication of the presence of a service only and should not be used for design. GPR scans are also represented as QL-D as the GPR image cannot be confirmed to it's origin point. Depths on GPR scan must be amount of reliance on it. Project risks related to underground utilities can then be managed. treated as indicative only.

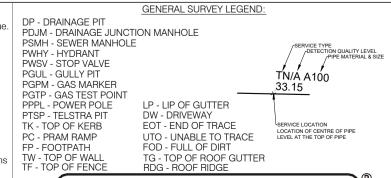

BEING INTEGRATED IS ON THE SAME COORDINATE SYSTEM

* REFER TO THE FACE OF THE PLAN FOR TITLE NOTATIONS SHOWING: PLAN SHEETING * BOUNDARIES HAVE BEEN DEFINED BY SURVEY. * CONTOURS ARE INDICATIVE OF LAND FORM. SPOT LEVELS TAKE PRECEDENCE. E:320781.682 N:6232486.032 ORIENTATION SS 146837 - PM 50616 AHD ORIGIN SS 146837 RL 109.976

PURPOSE: DUE DILIGENCE-DESIGN

SHEET 01 0F 05

Astrea

DIGITAL SURVEY SOLUTIONS

39 DELHI ROAD, NORTH RYDE 2113


SCOTT DEVERIDGE 0425 285 270 www.astrea.com.au

SUITE 6.01, TRINITI II, TRINITI BUSINESS PARK

UTILITY MAPPING





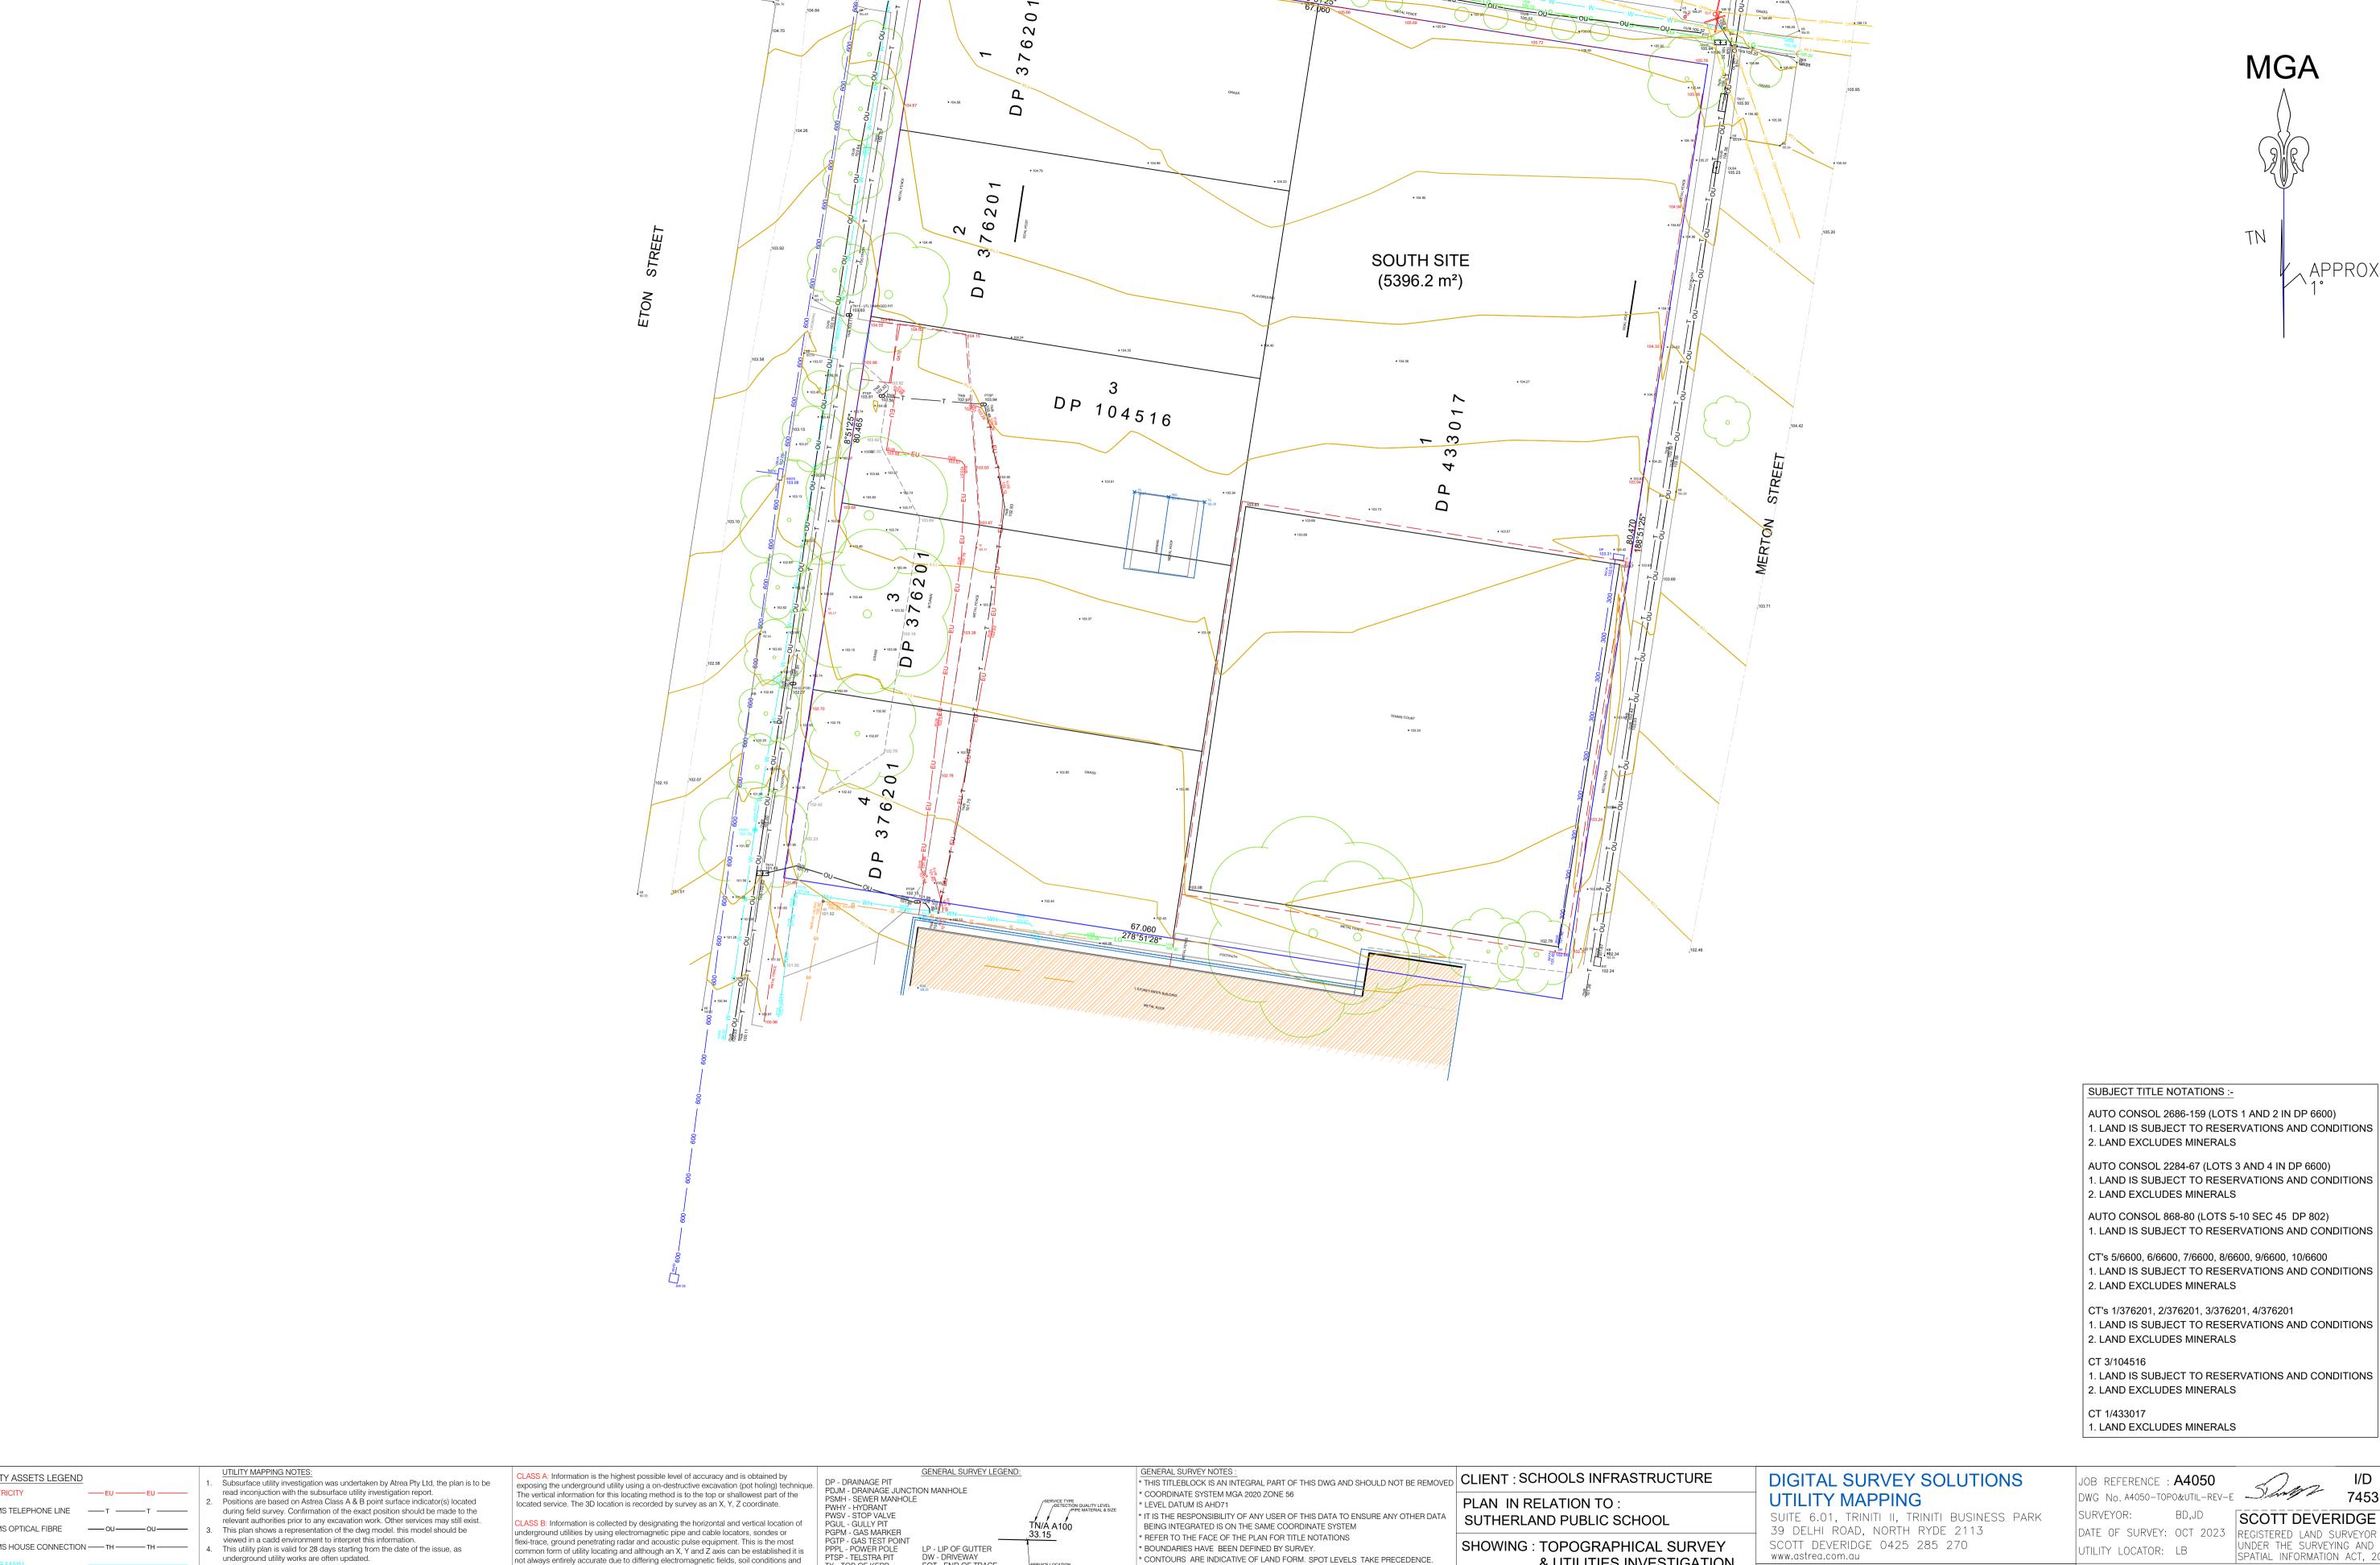

SUBJECT TITLE NOTATIONS:-

AUTO CONSOL 2284-67 (LOTS 3 AND 4 IN DP 6600)

MGA

1. LAND IS SUBJECT TO RESERVATIONS AND CONDITIONS 2. LAND EXCLUDES MINERALS

AUTO CONSOL 868-80 (LOTS 5-10 SEC 45 DP 802)

CT's 5/6600, 6/6600, 7/6600, 8/6600, 9/6600, 10/6600 1. LAND IS SUBJECT TO RESERVATIONS AND CONDITIONS

CT's 1/376201, 2/376201, 3/376201, 4/376201

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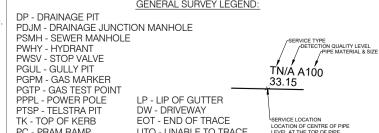
1. LAND EXCLUDES MINERALS

Astrea

JOB REFERENCE : A4050 DWG No. A4050-TOPO&UTIL-REV-E UNDER THE SURVEYING AND ISPATIAL INFORMATION ACT. 2002 UTILITY LOCATOR: LB

	SPATIAL INFORMATI	UN ACI, ZU		
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D	PIT ANNOTAION ADDED	08.10.2024		
С	ADDITIONAL SURVEY DATA	30.09.2024		
В	AMENDMENTS	26.08.202		
А	BUILDING DESCRIPTION	16.11.2023		
REV	AMENDMENTS	DATE		

- UTILITY ASSETS LEGEND ELECTRICITY COMMS TELEPHONE LINE
- compiled from a combination of field techniques and available data from cooperating utility authorities. Whilst all care has been taken in the preparation of
- Electricity cables are not necessarily enclosed in conduits and are not
 - necessarily covered with markers, tape or other indicators of their presence. 6. All services have been electronically traced in the field and are shown here for diagrammatic purposes only. Depths shown are approximate only and should be verified prior to works. This plan includes information describing the location of subterranean features, which were purported to exist at the time of the survey. This information was
 - this plan of survey, we cannot guarantee that the plan is without flaw of any kind. SUBSURFACE UTILITY INFORMATION (SUI) AS5488 LOCATION CLASS Labelling utility information by a classification code allows the user of this information to understand clearly how the information was collected and then place an appropriate
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UTO - UNABLE TO TRACE FOD - FULL OF DIRT PC - PRAM RAMP TG - TOP OF ROOF GUTTER RDG - ROOF RIDGE

SCALE 1:250					
5 1	0 15	5 2	20 25		
CDA 🗪	ORIGIN	SS146837 E:320781.6	682 N:6232486.03	2	
GDA A	ORIENTATION	SS 146837 -	PM 50616		
2020	AHD ORIGIN	SS 146837 F	RL 109.976	_	

& UTILITIES INVESTIGATION

SHEET 04 0F 05

PURPOSE: DUE DILIGENCE-DESIGN



TG - TOP OF ROOF GUTTER RDG - ROOF RIDGE

SCALE 1:150

ORIGIN

SS146837

ORIENTATION SS 146837 - PM 50616

AHD ORIGIN SS 146837 RL 109.976

E:320781.682 N:6232486.032

PURPOSE: DUE DILIGENCE-DESIGN

SHEET 05 0F 05

0 1 2 3 4 5

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SEWER MAIN

diagrammatic purposes only. Depths shown are approximate only and should

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SUBSURFACE UTILITY INFORMATION (SUI) AS5488 LOCATION CLASS

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SURVEYOR:

JOB REFERENCE : A4050

UTILITY LOCATOR: LB

DWG No. A4050-TOPO&UTIL-REV-E

SCOTT DEVERIDGE

UNDER THE SURVEYING AND SPATIAL INFORMATION ACT, 2002

DATE OF SURVEY: OCT 2023 REGISTERED LAND SURVEYOR